
State of Utah-DFCM Utah National Guard Logan Armory Roofing Improvements Logan, Utah

Project Number:

05041470

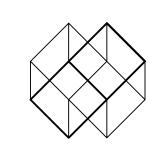

Harold P. Woodruff Architect\Planner 223 East 800 South Salt Lake City, Utah 84111 Phone: 801-355-8684 Fax: 801-359-3780

CONSULTANTS:

Structural Engineer: George H. Hansen, Inc. 254 East First South Salt Lake City, Utah 84111 Phone: 801-519-2111

Mechanical Engineer: Spectrum

175 South Main Street, Suite 300 Salt Lake City, Utah 84111 Phone: 801-328-5151

Electrical Engineer:
Thomas and Kolkman Engineering
64 West 1700 South
Salt Lake City, Utah 84115
Phone: 801-484-8161

PROJECT TITLE:

Logan Armory-Roofing **Improvements**

OWNER:

State of Utah-DFCM Utah National Guard Salt Lake City, Utah

MARK DATE DESCRIPTION ISSUE TYPE: CONSTRUCTION DOCS.

ISSUE DATE: SEPTEMBER 19, 2005

DFCM PROJECT NO: 05041470 CONTRACT NO: N/A CAD PROJECT NO: N/A

CAD DWG FILE: N/A ARCH PROJECT FILE: 0506.pj\q001cd.db D.D. DRAWN BY: D.D. CHK'D BY: COPYRIGHT State of Utah

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TITLE SHEET

SHEET NUMBER

G-001

OF


SHEET

DFCM Contract Number: N/A

State of Utah-Department of Administrative Services

DIVISION OF FACILITIES CONSTRUCTION AND MANAGEMENT


4110 State Office Building / Salt Lake City, utah 84114 / 538-3018

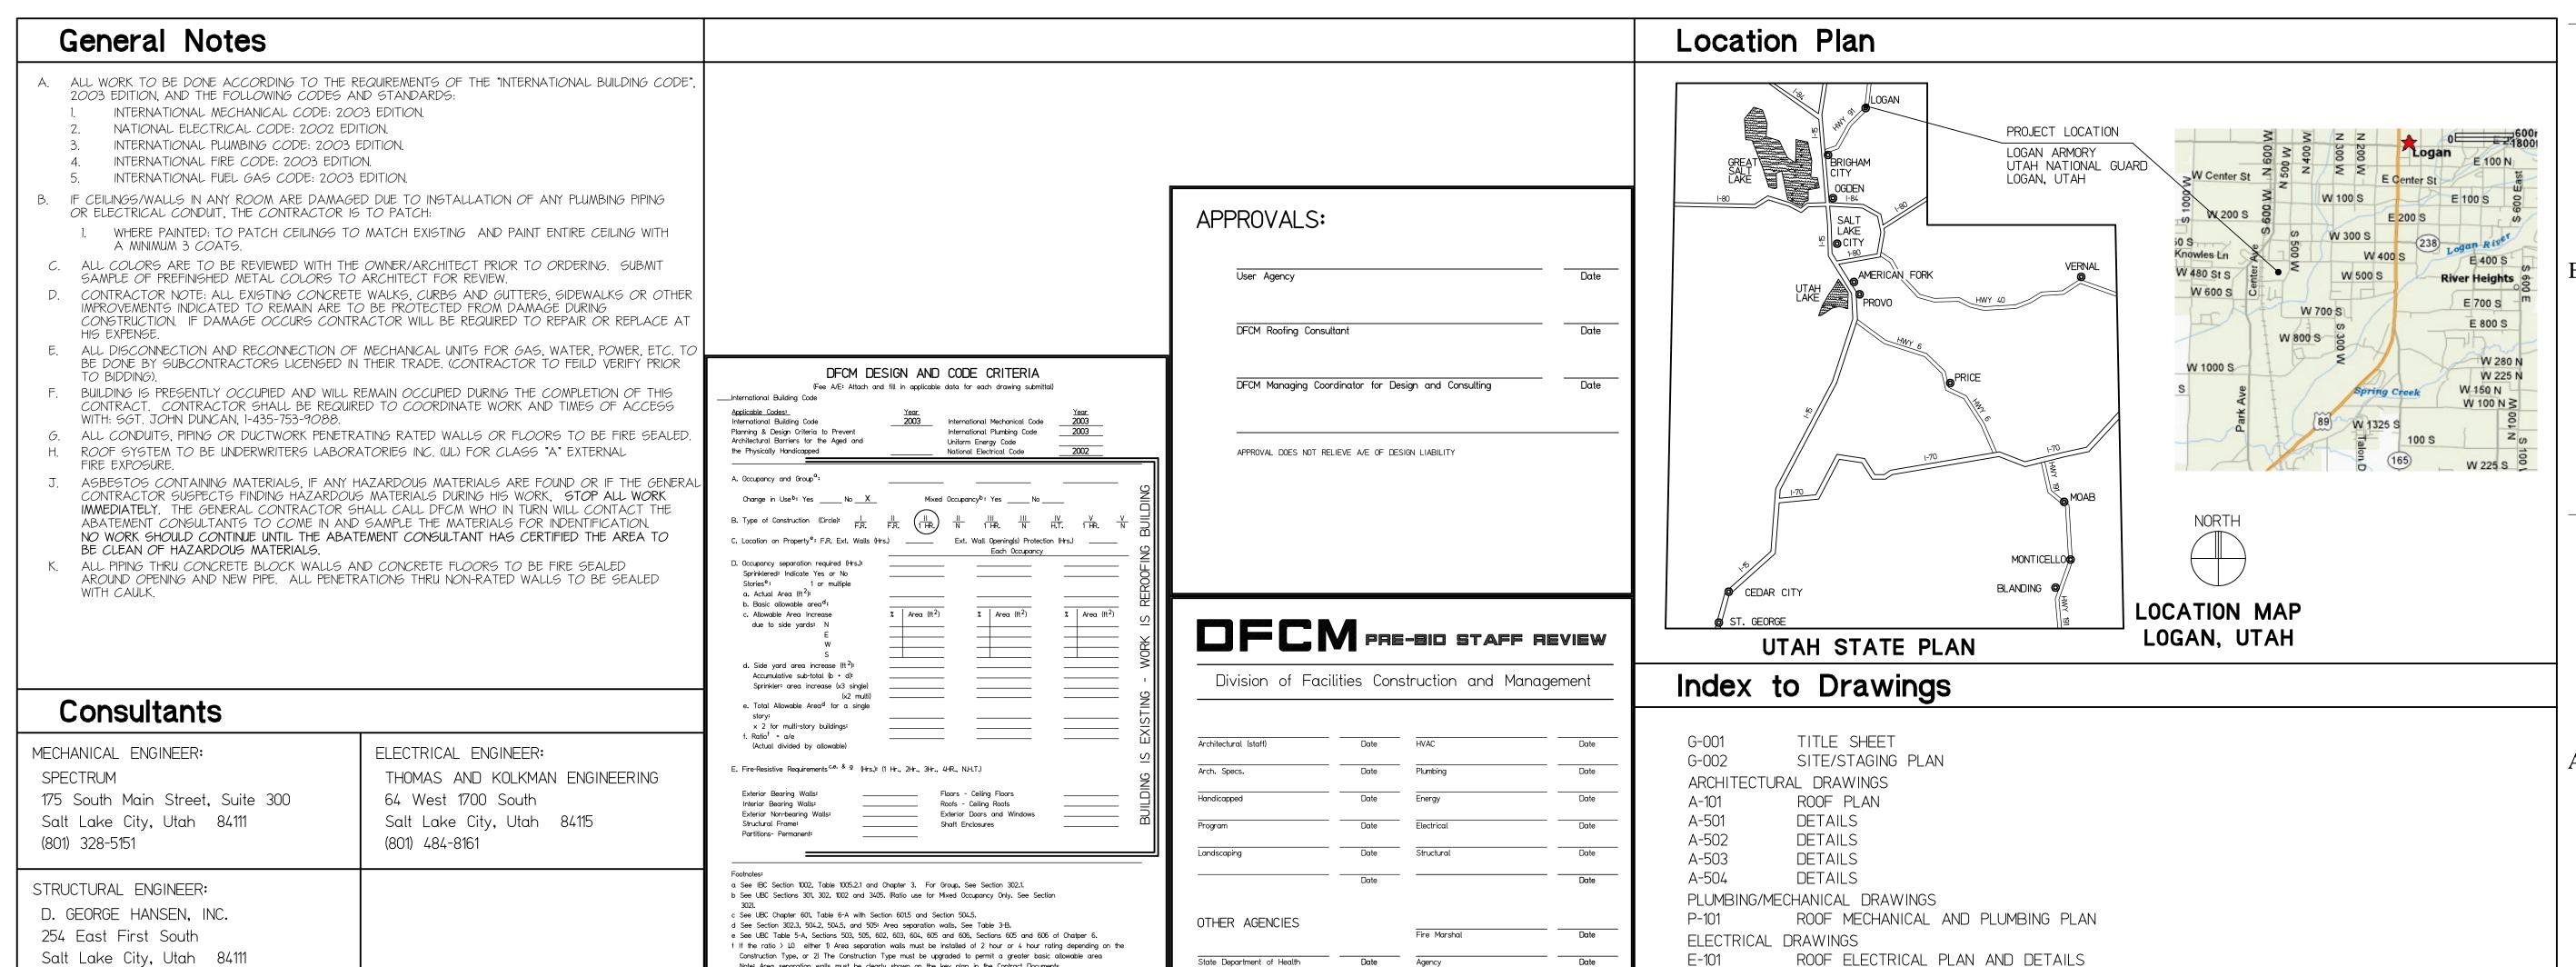


REVIEW DOES NOT RELIEVE A/E OF DESIGN LIABILITY

Note: Area separation walls must be clearly shown on the key plan in the Contract Documents.

(801) 519-2111

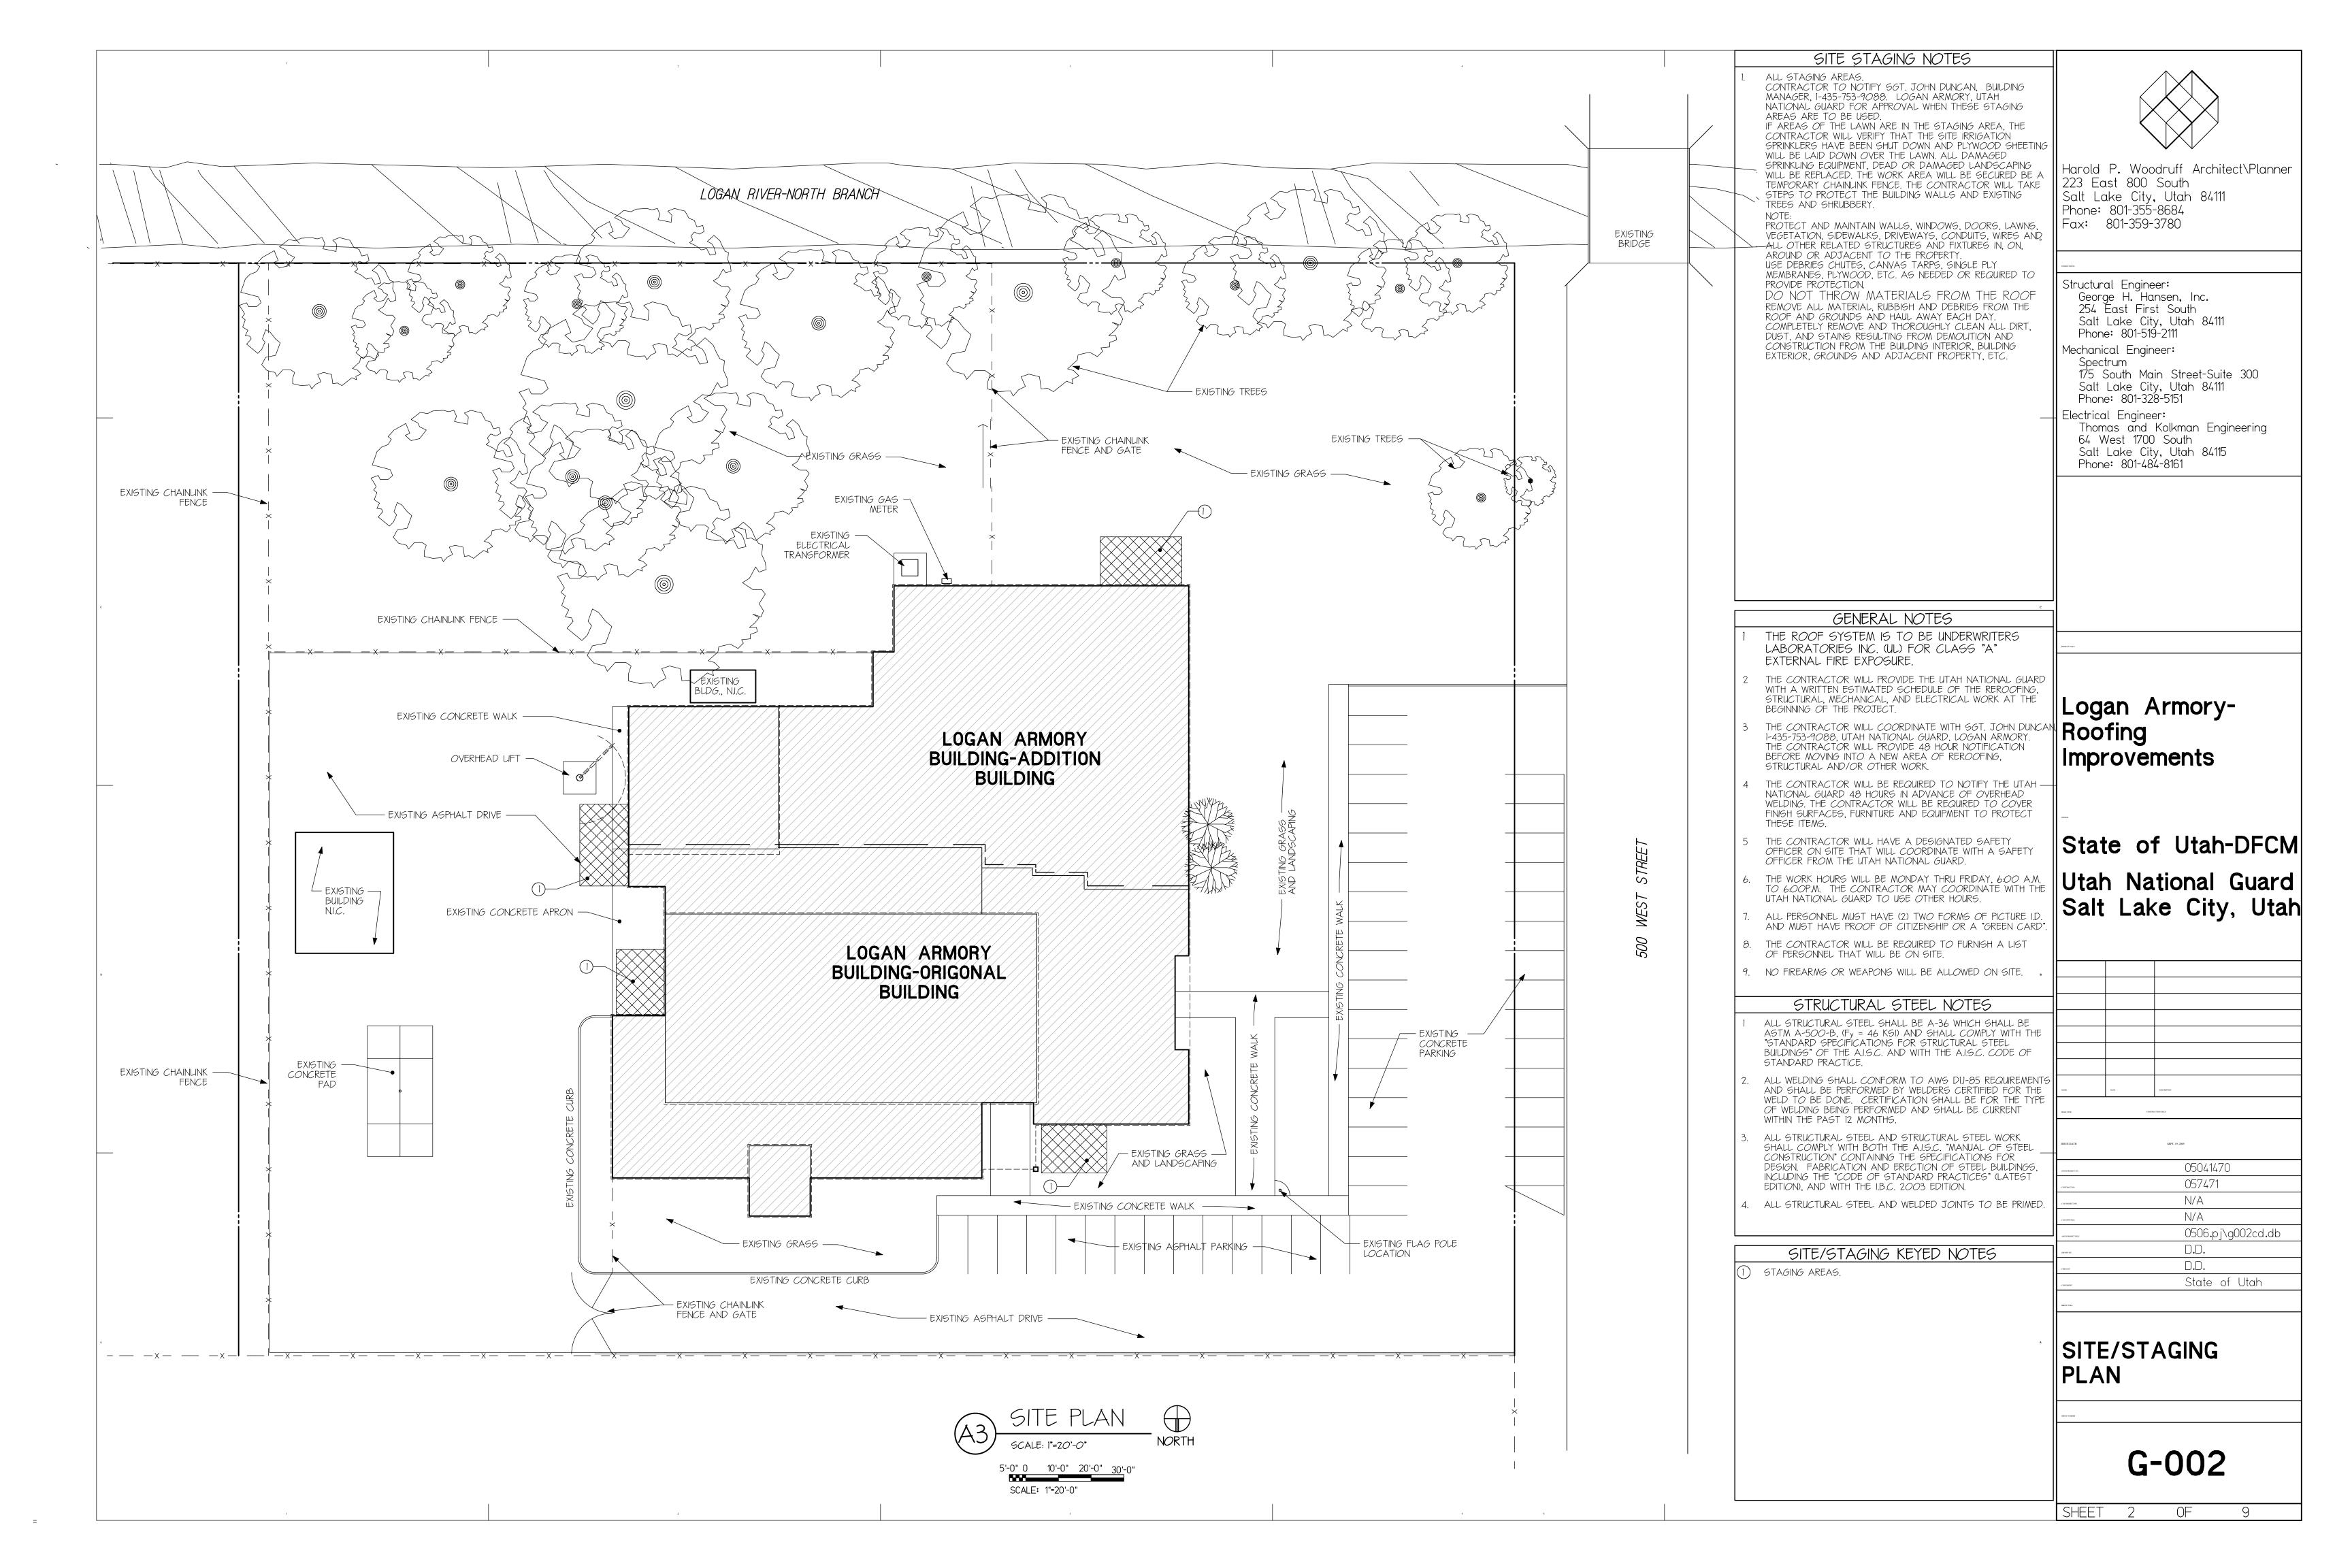


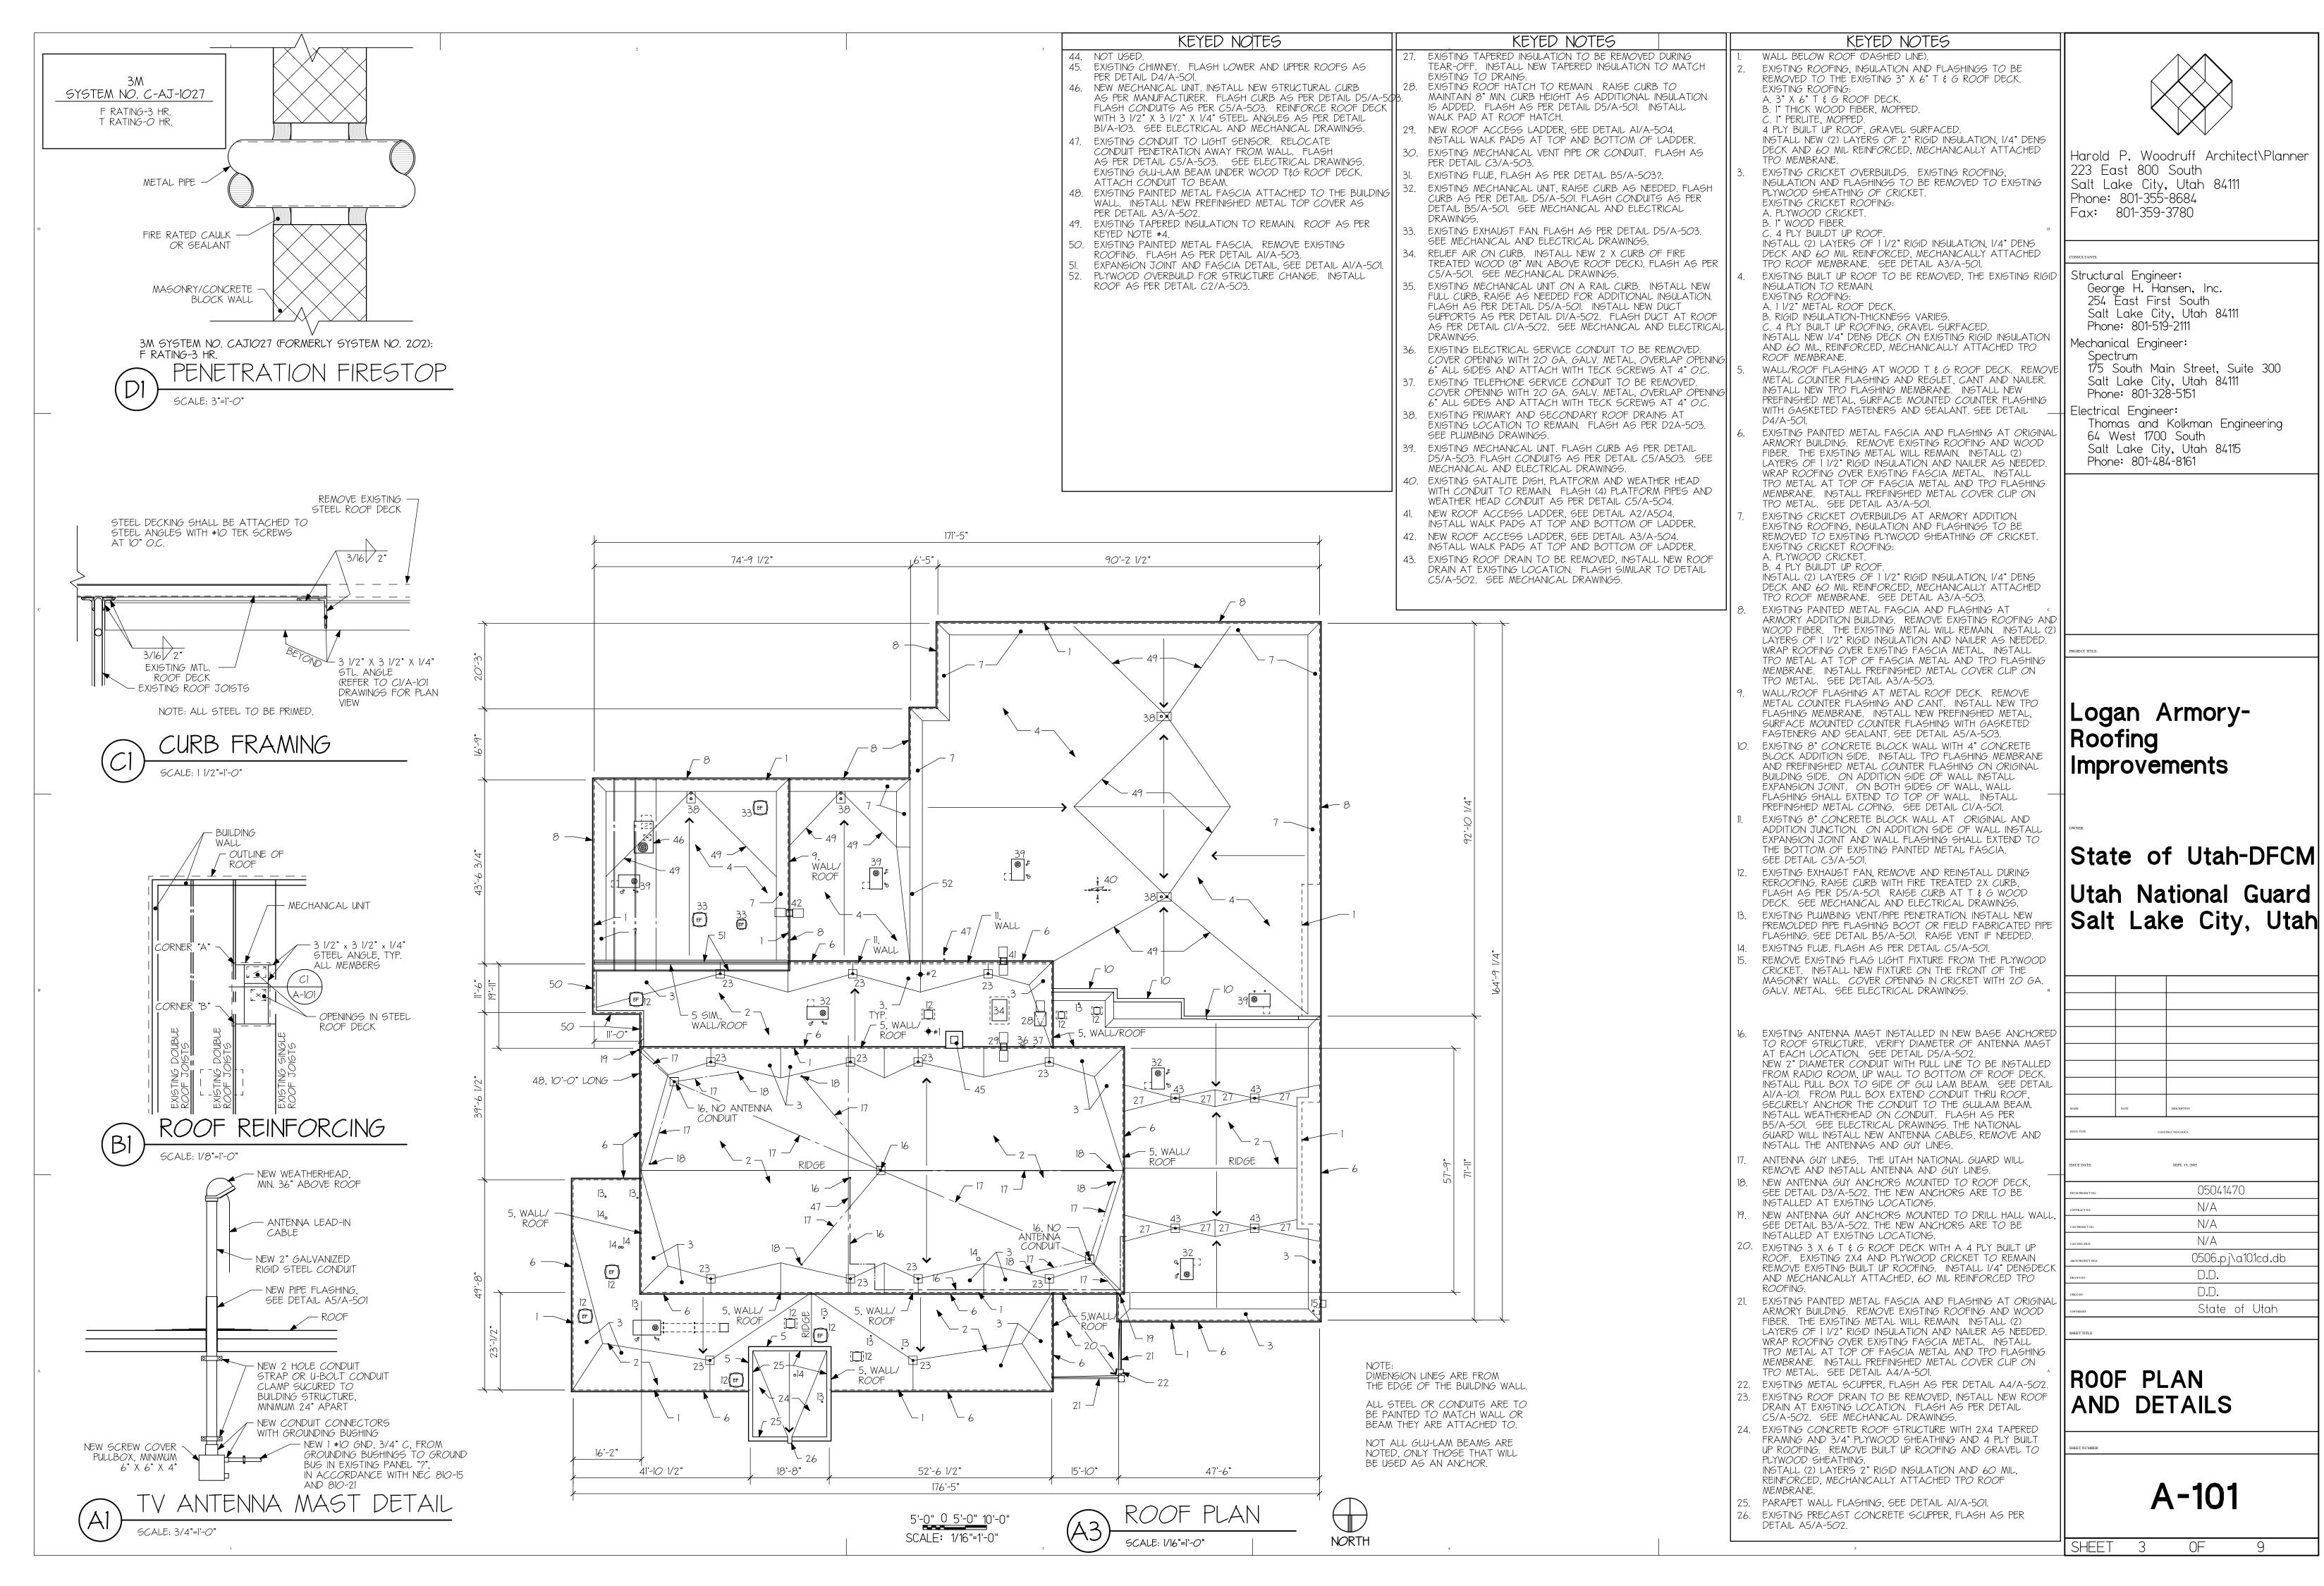



Harold P. Woodruff Architect\Planner


State of Utah-DFCM


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BY:	D.D.						
RIGHT:	State of Utah						
T TITLE							

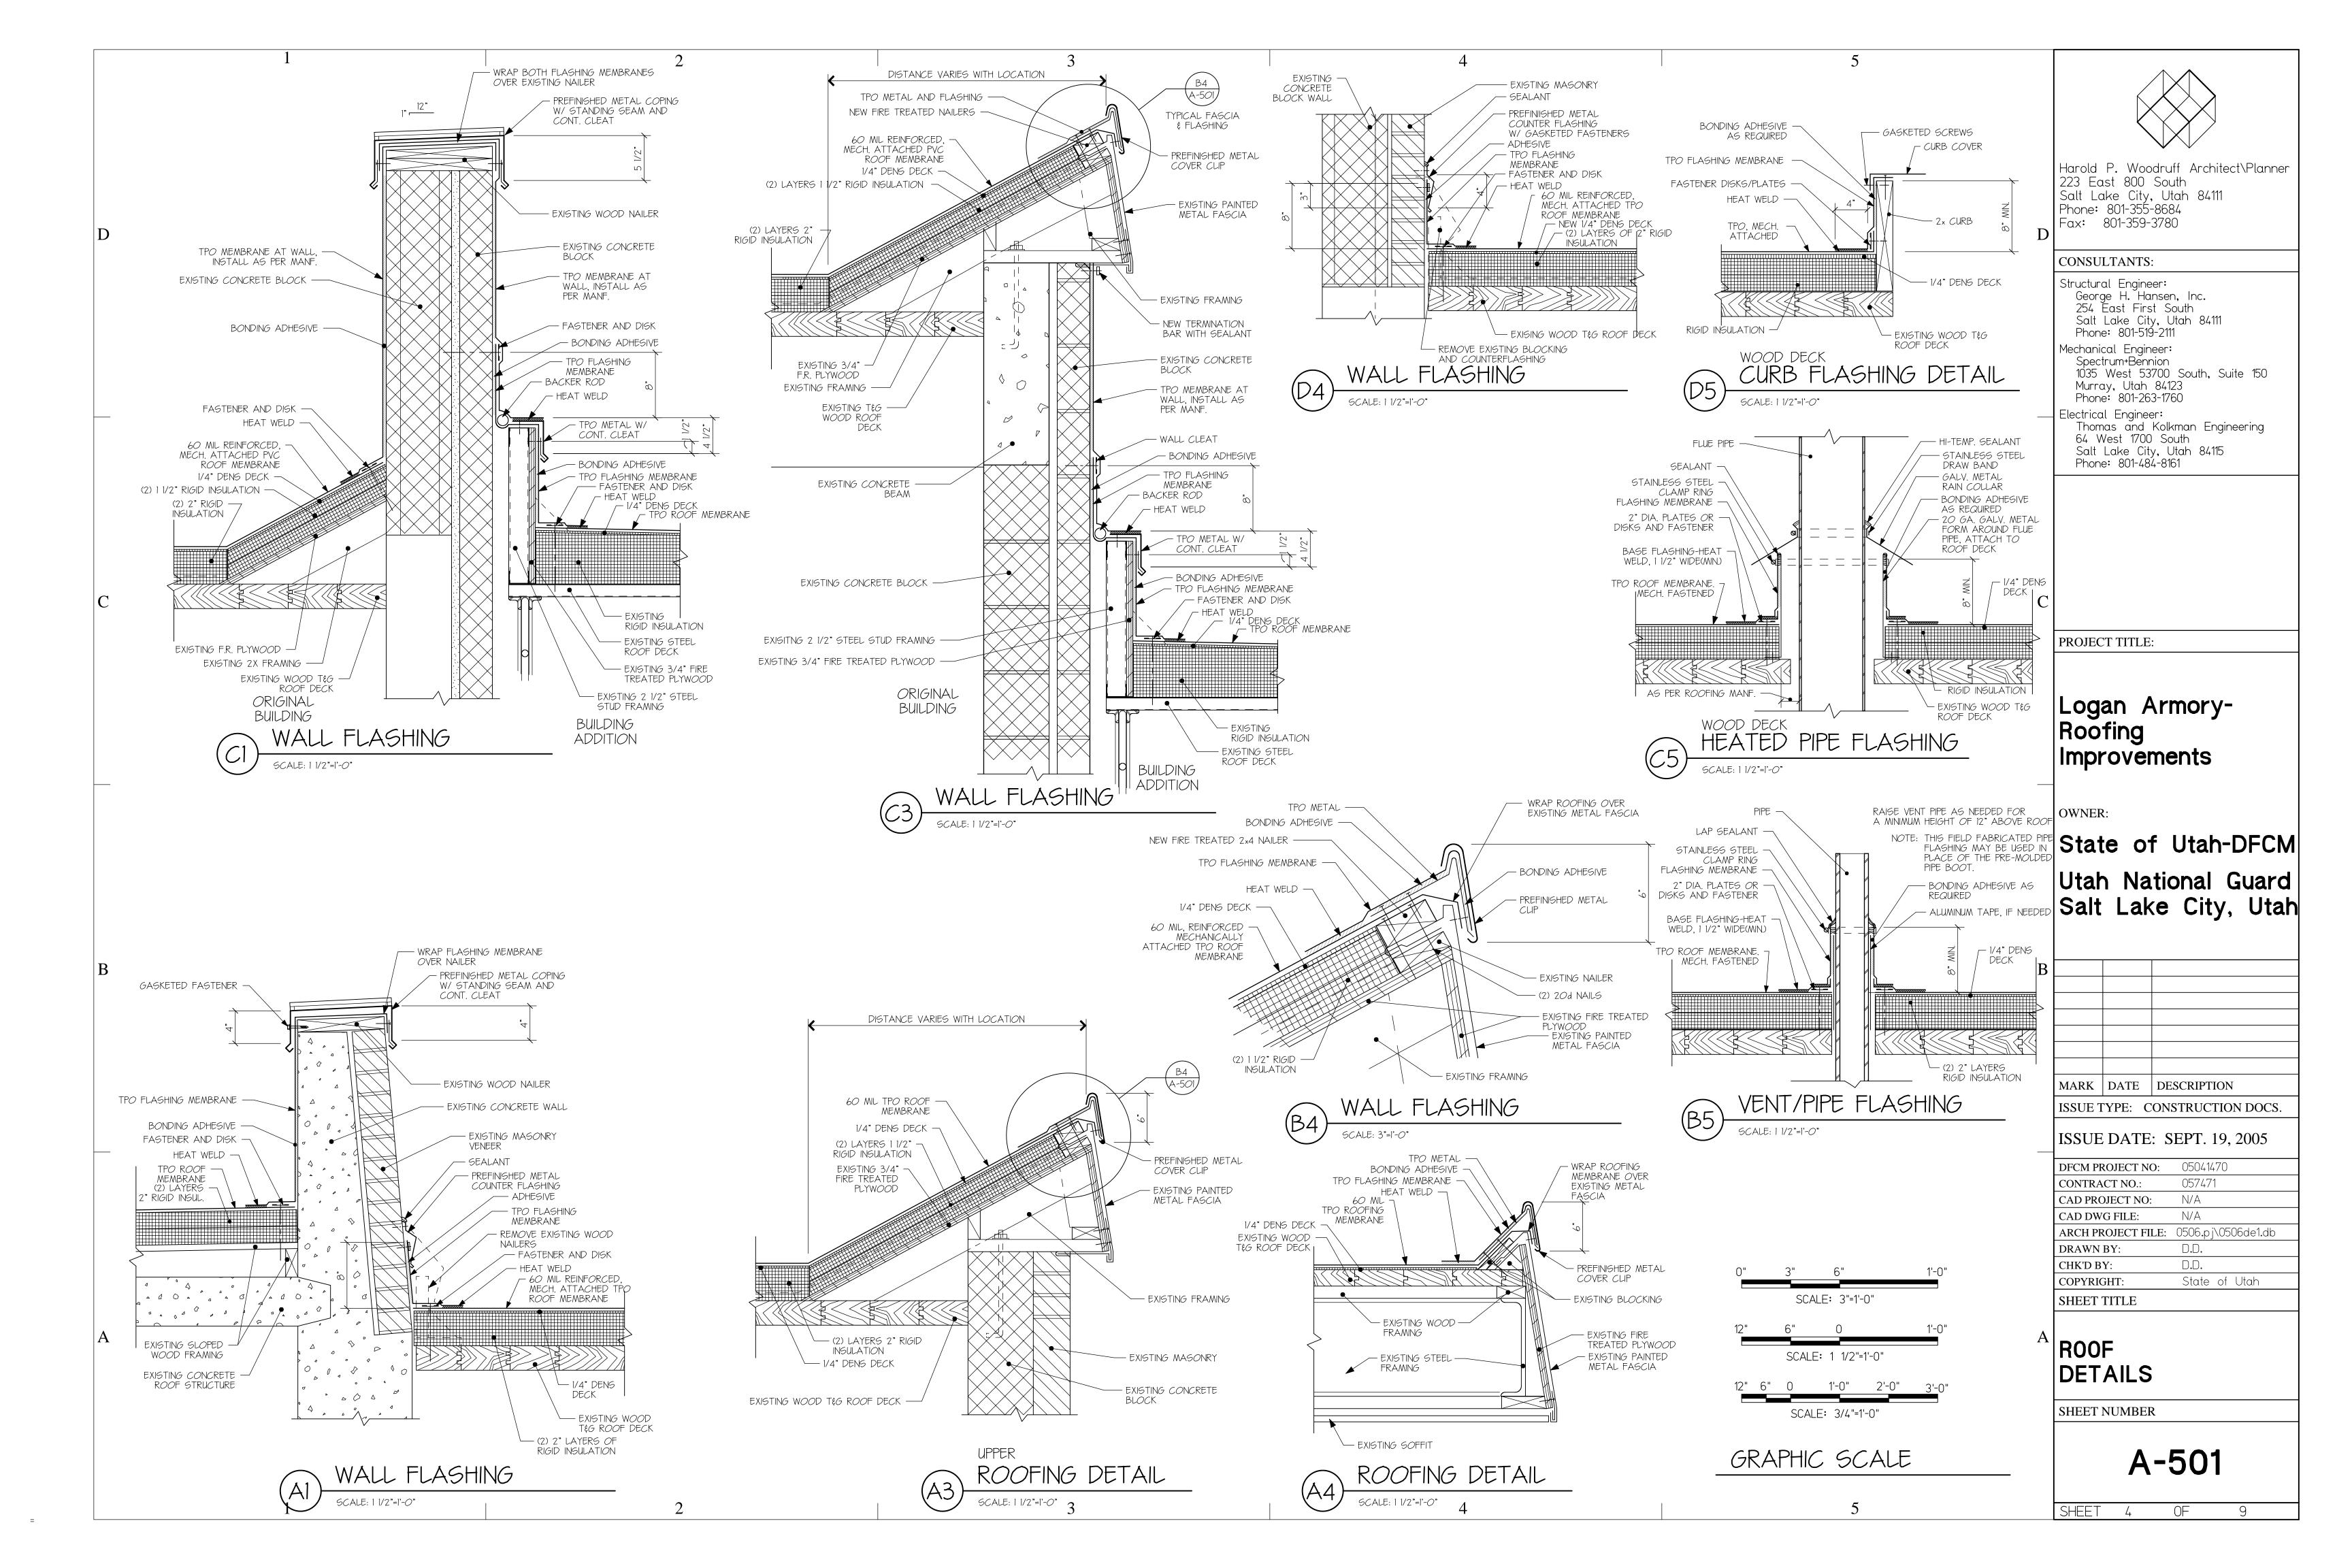

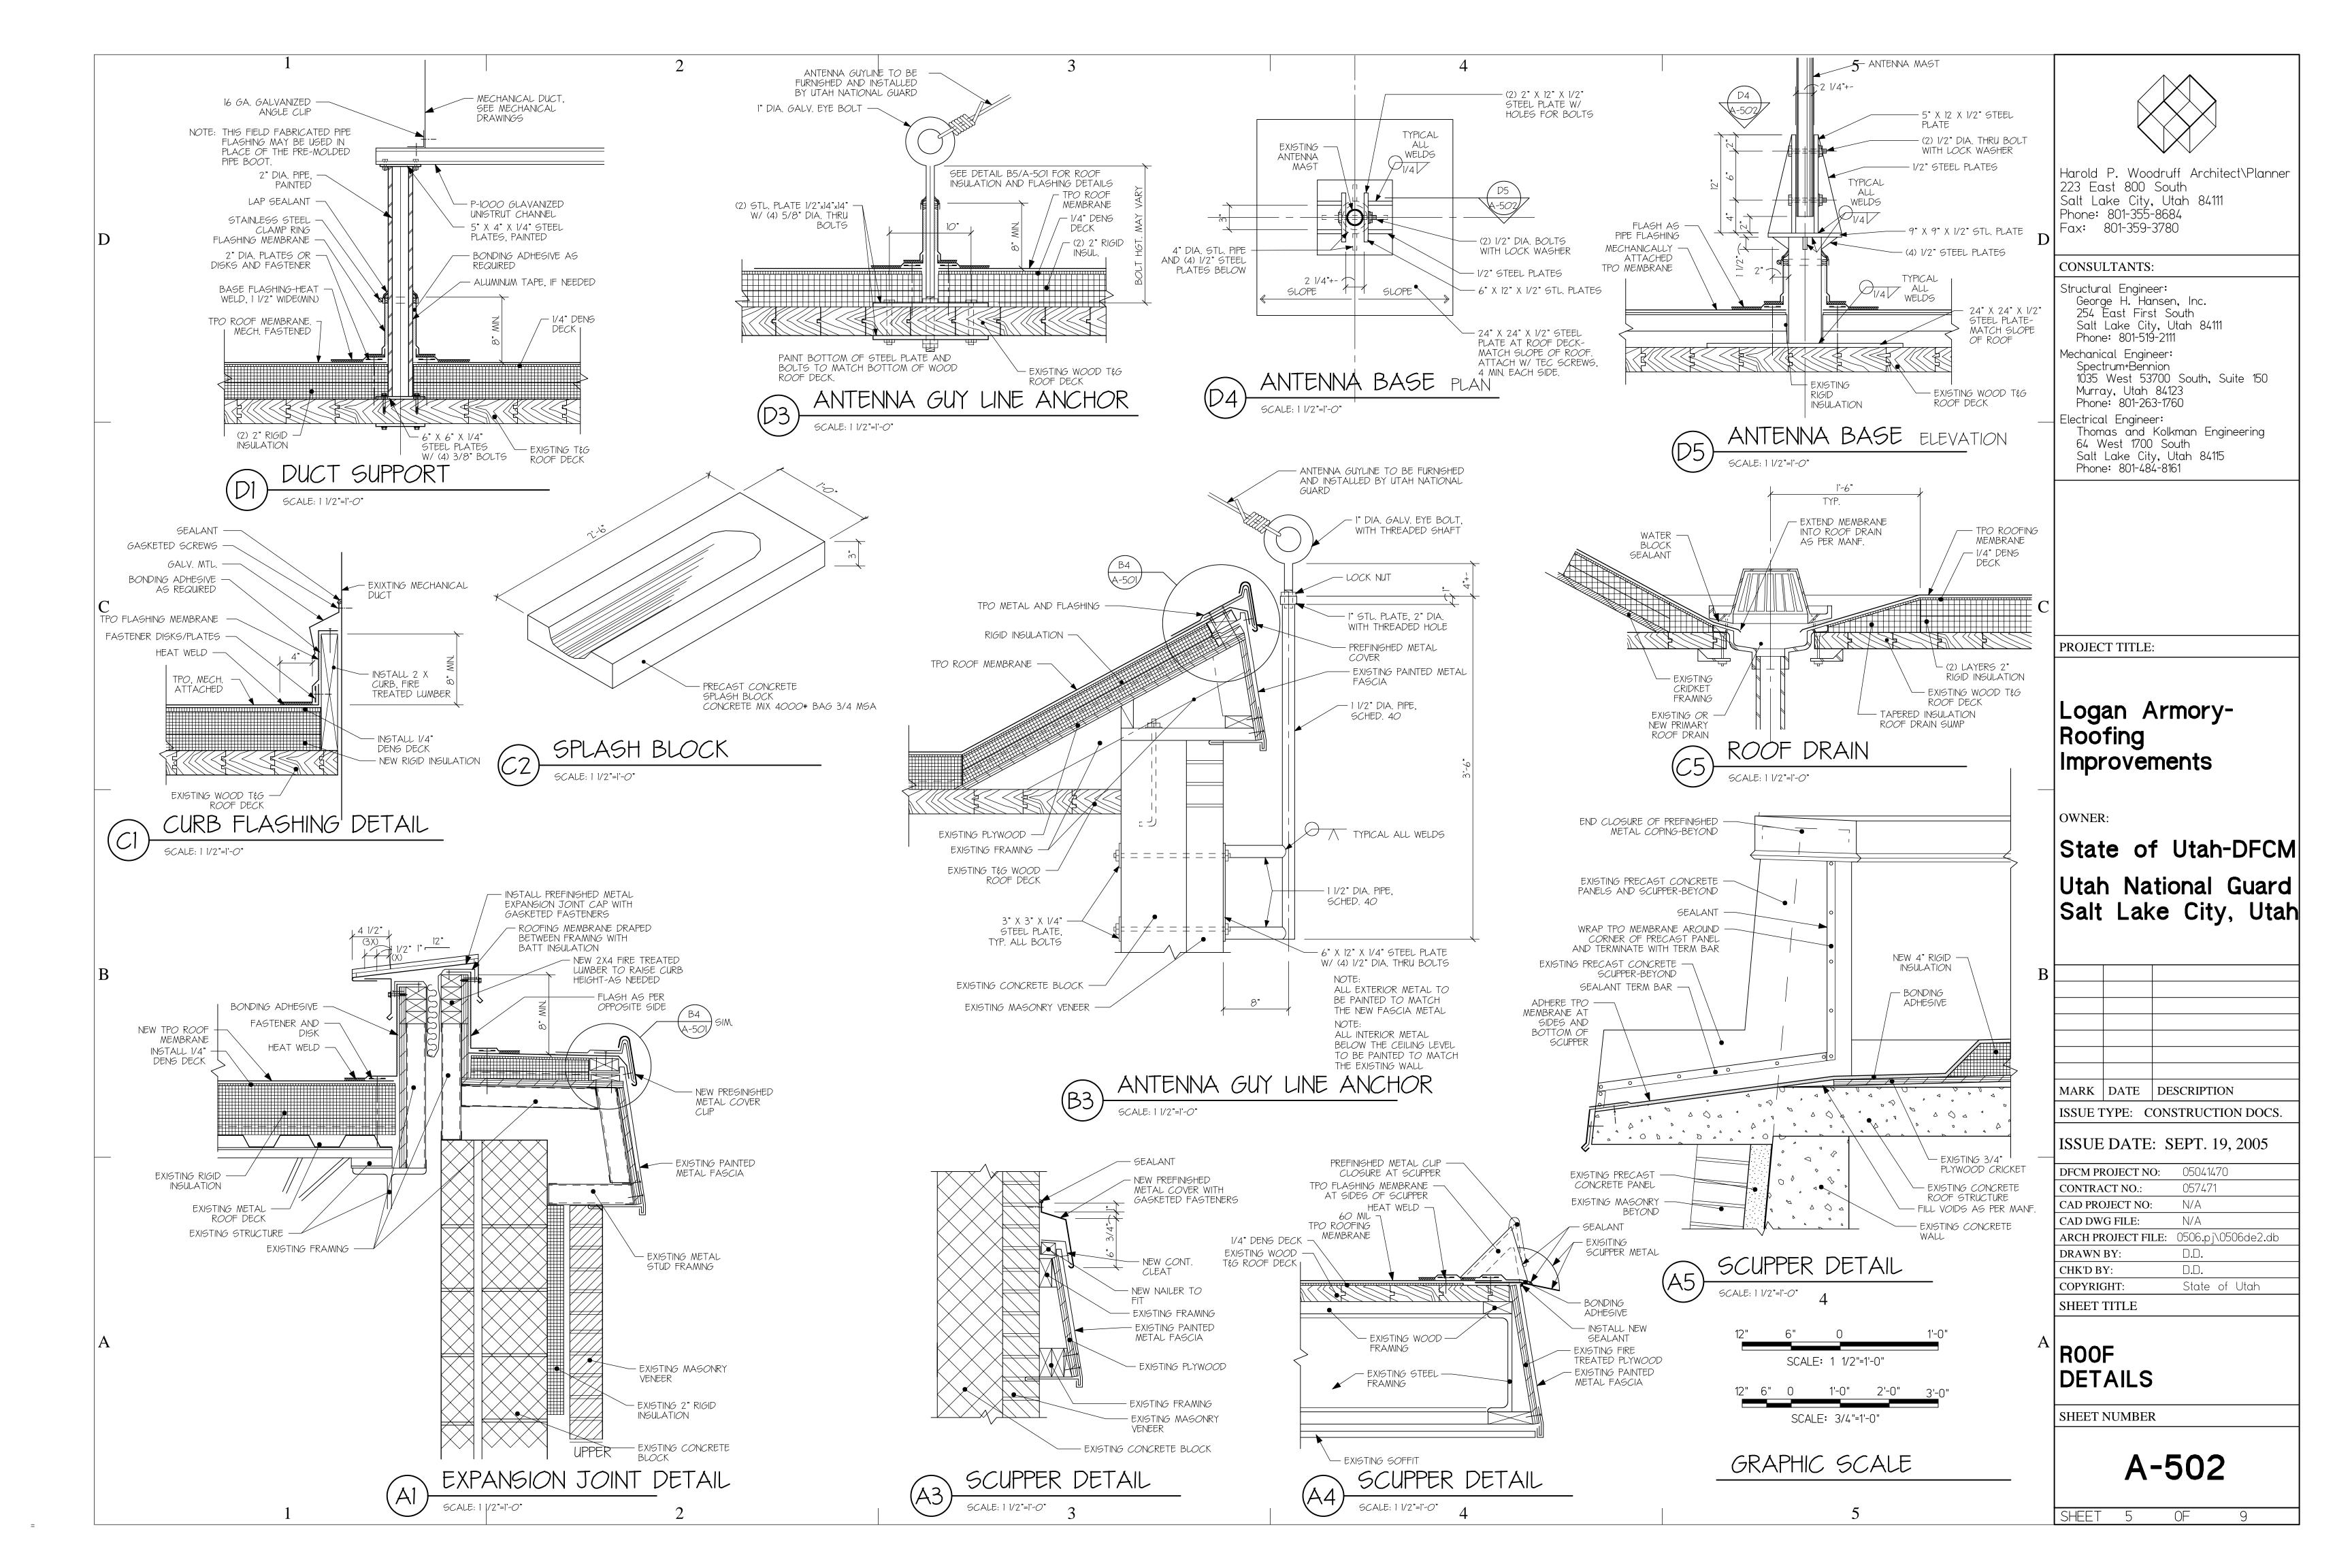

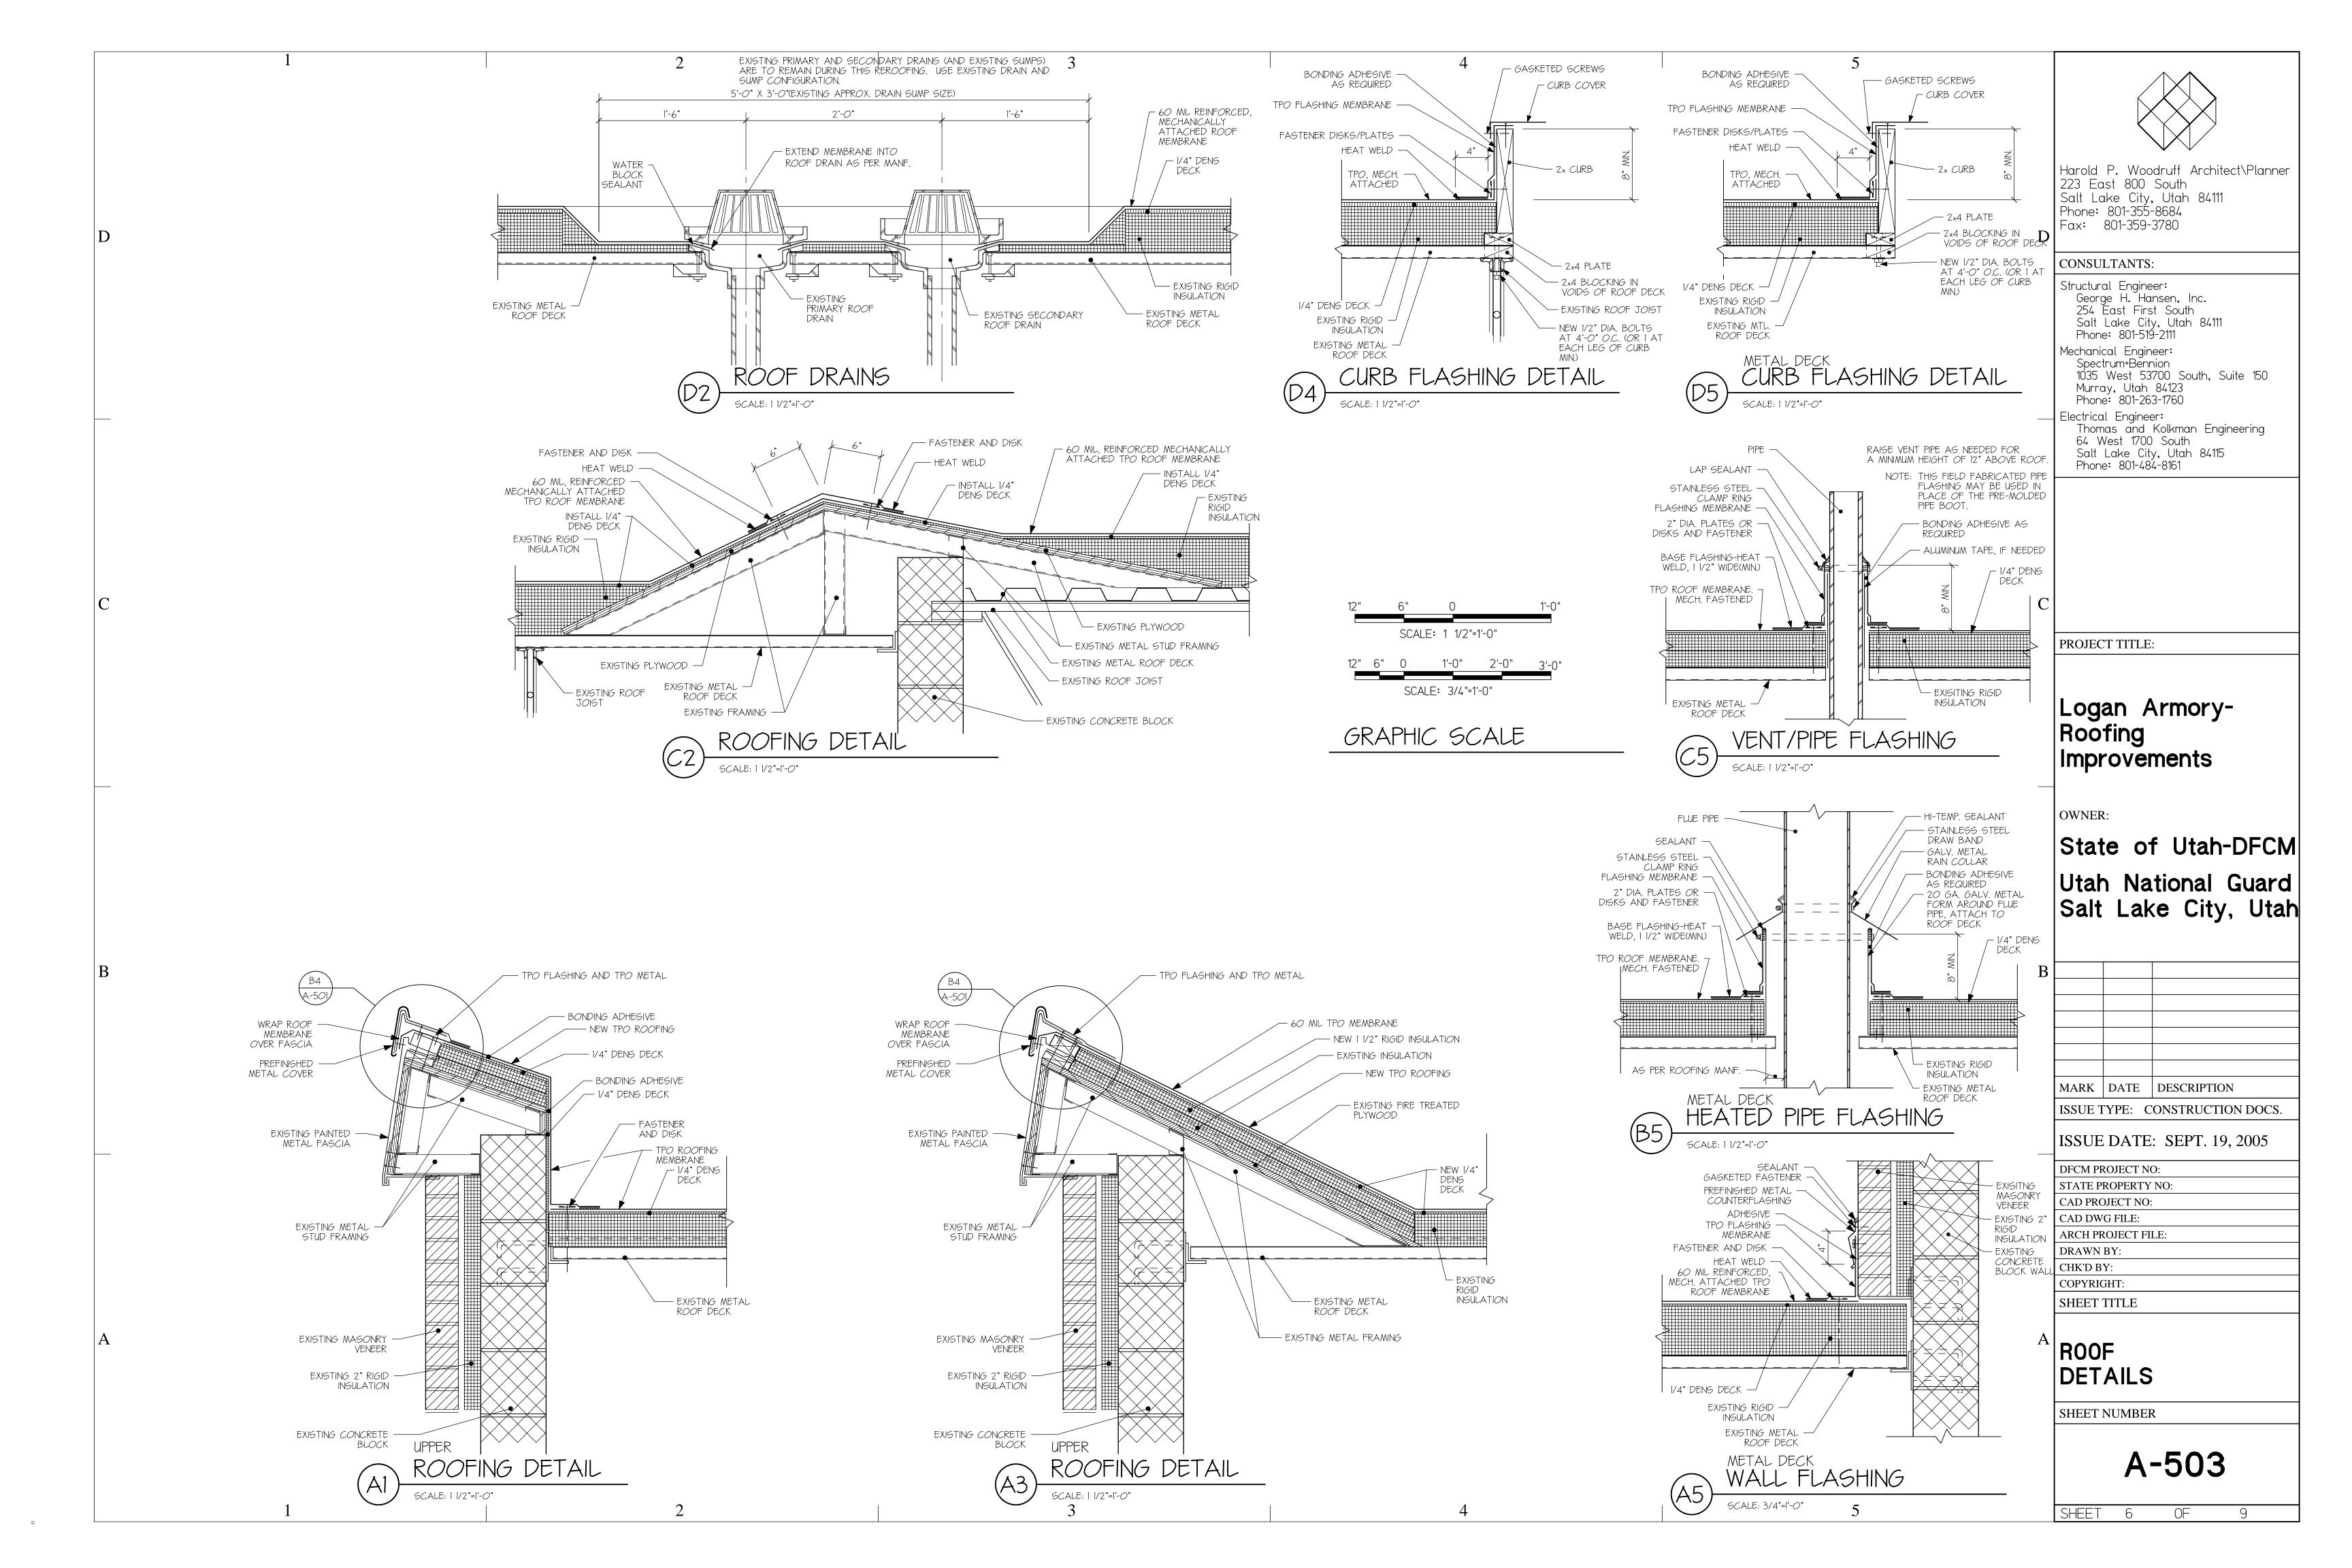

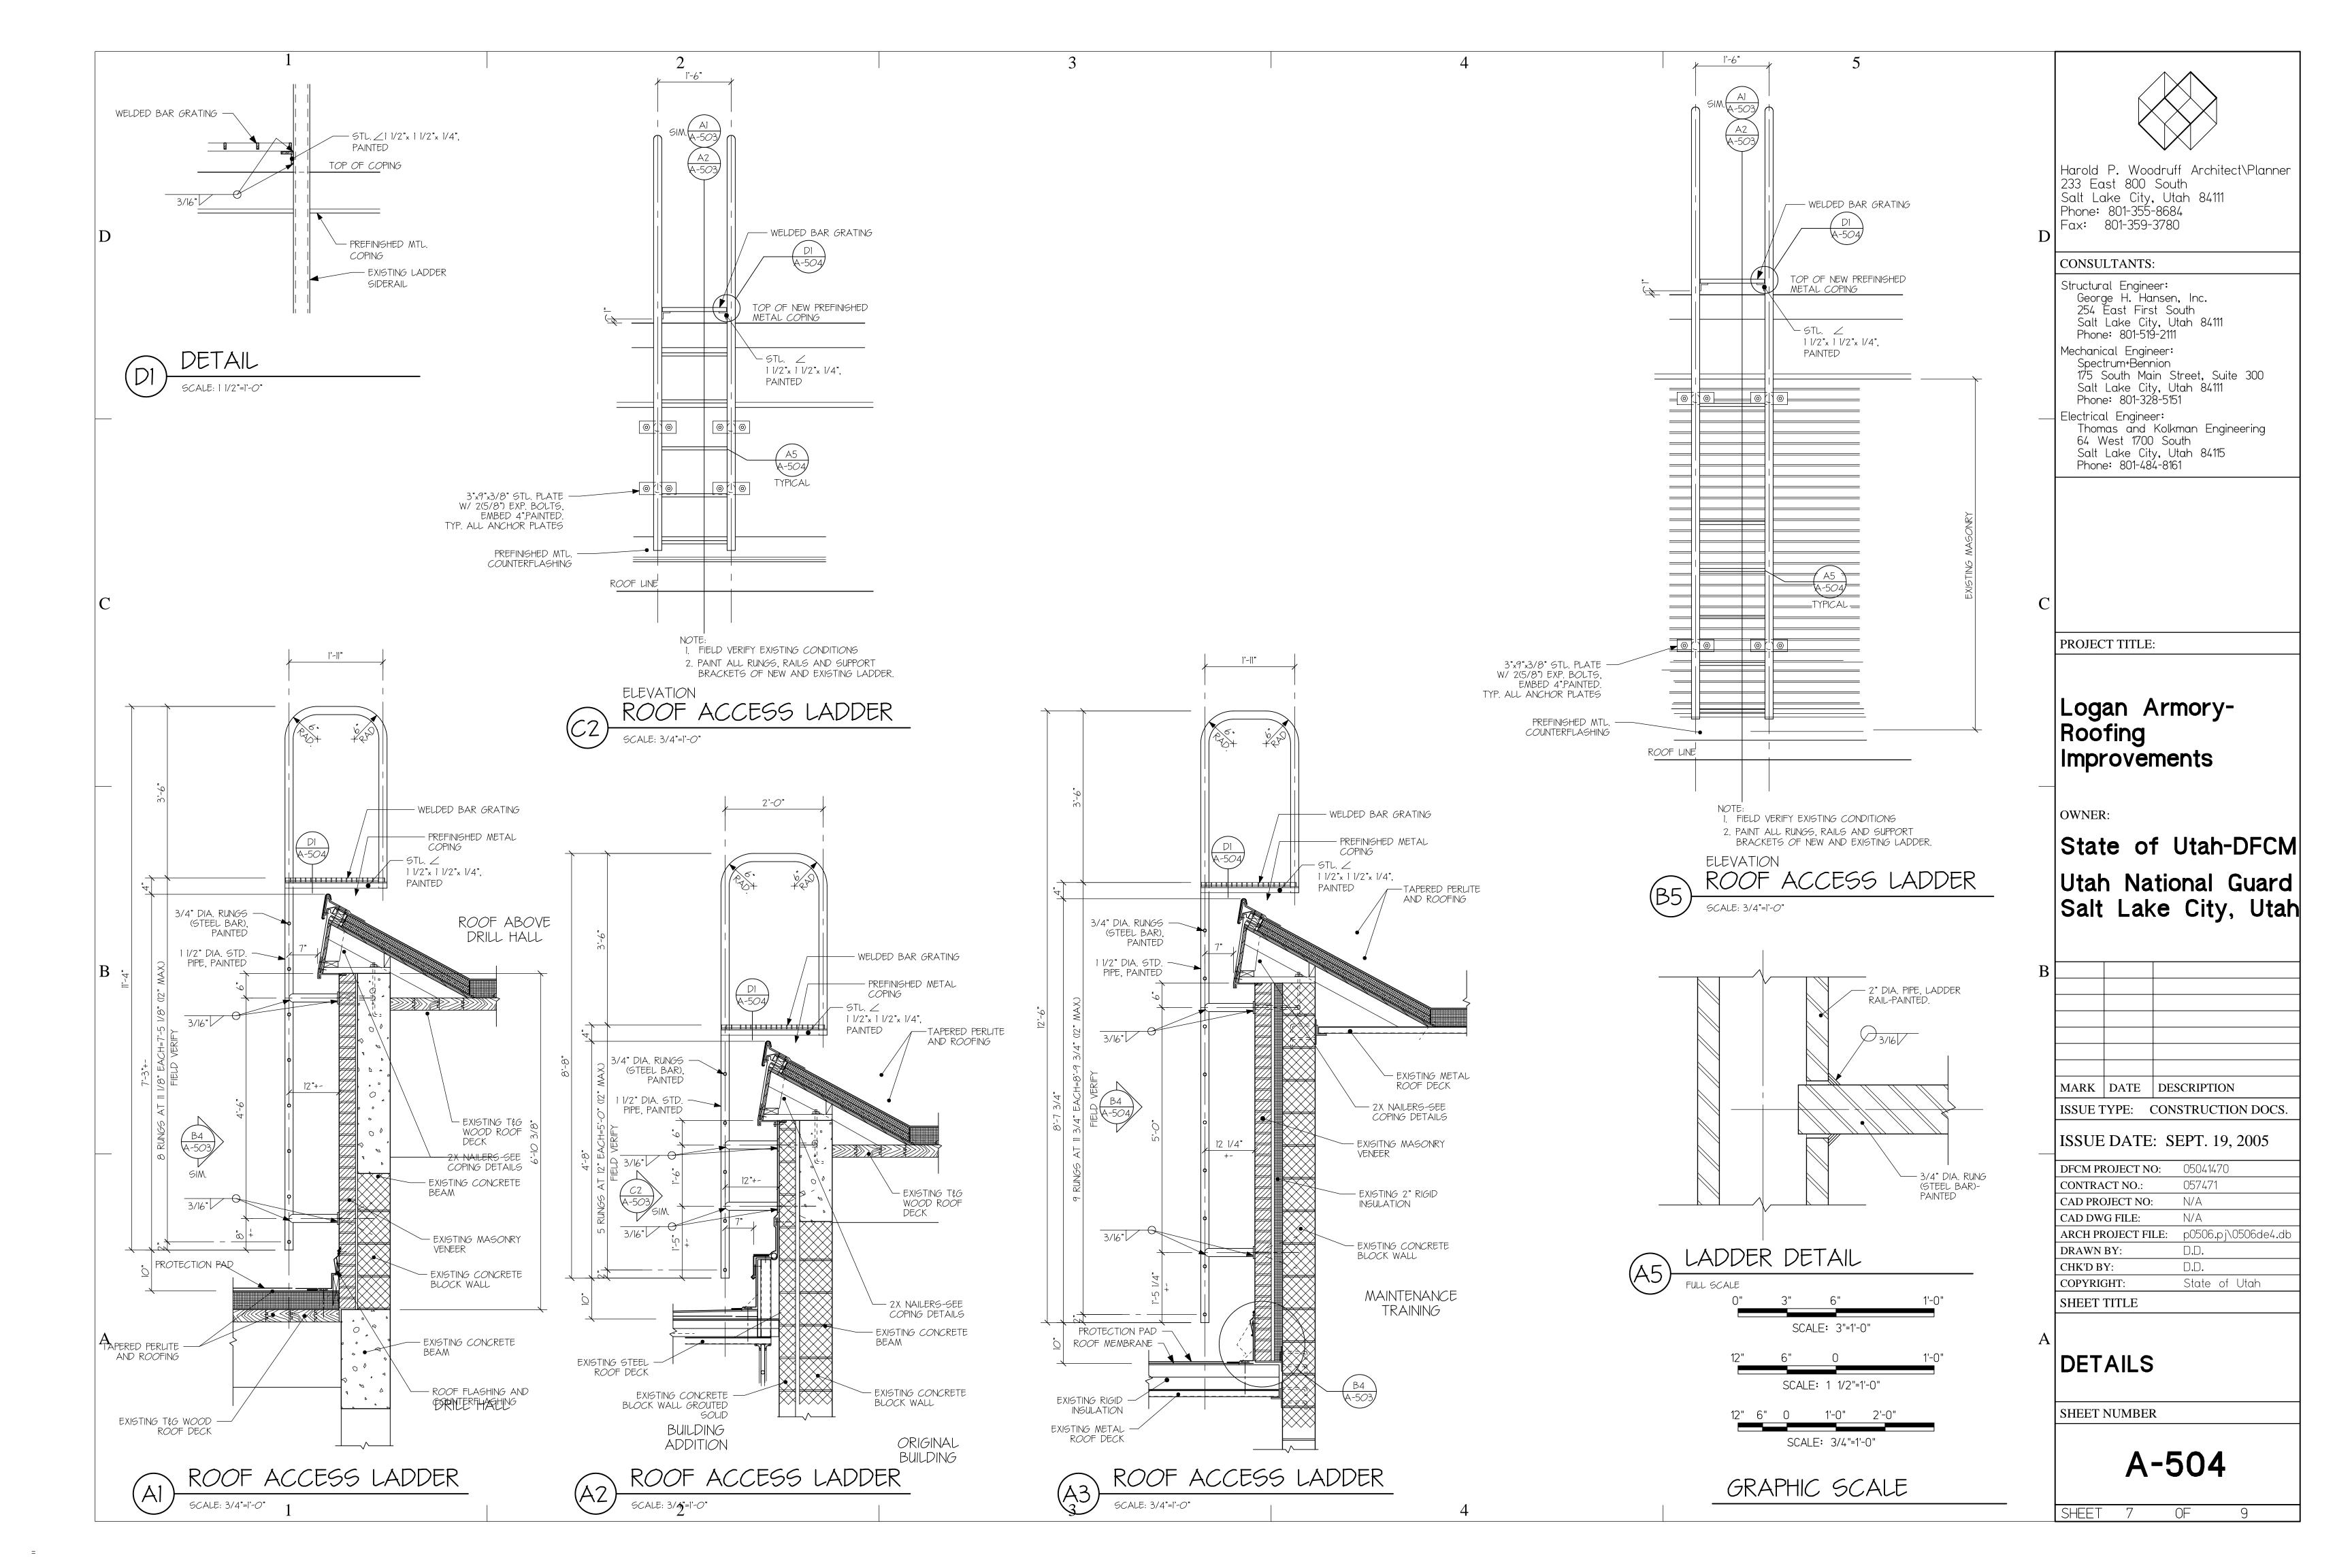

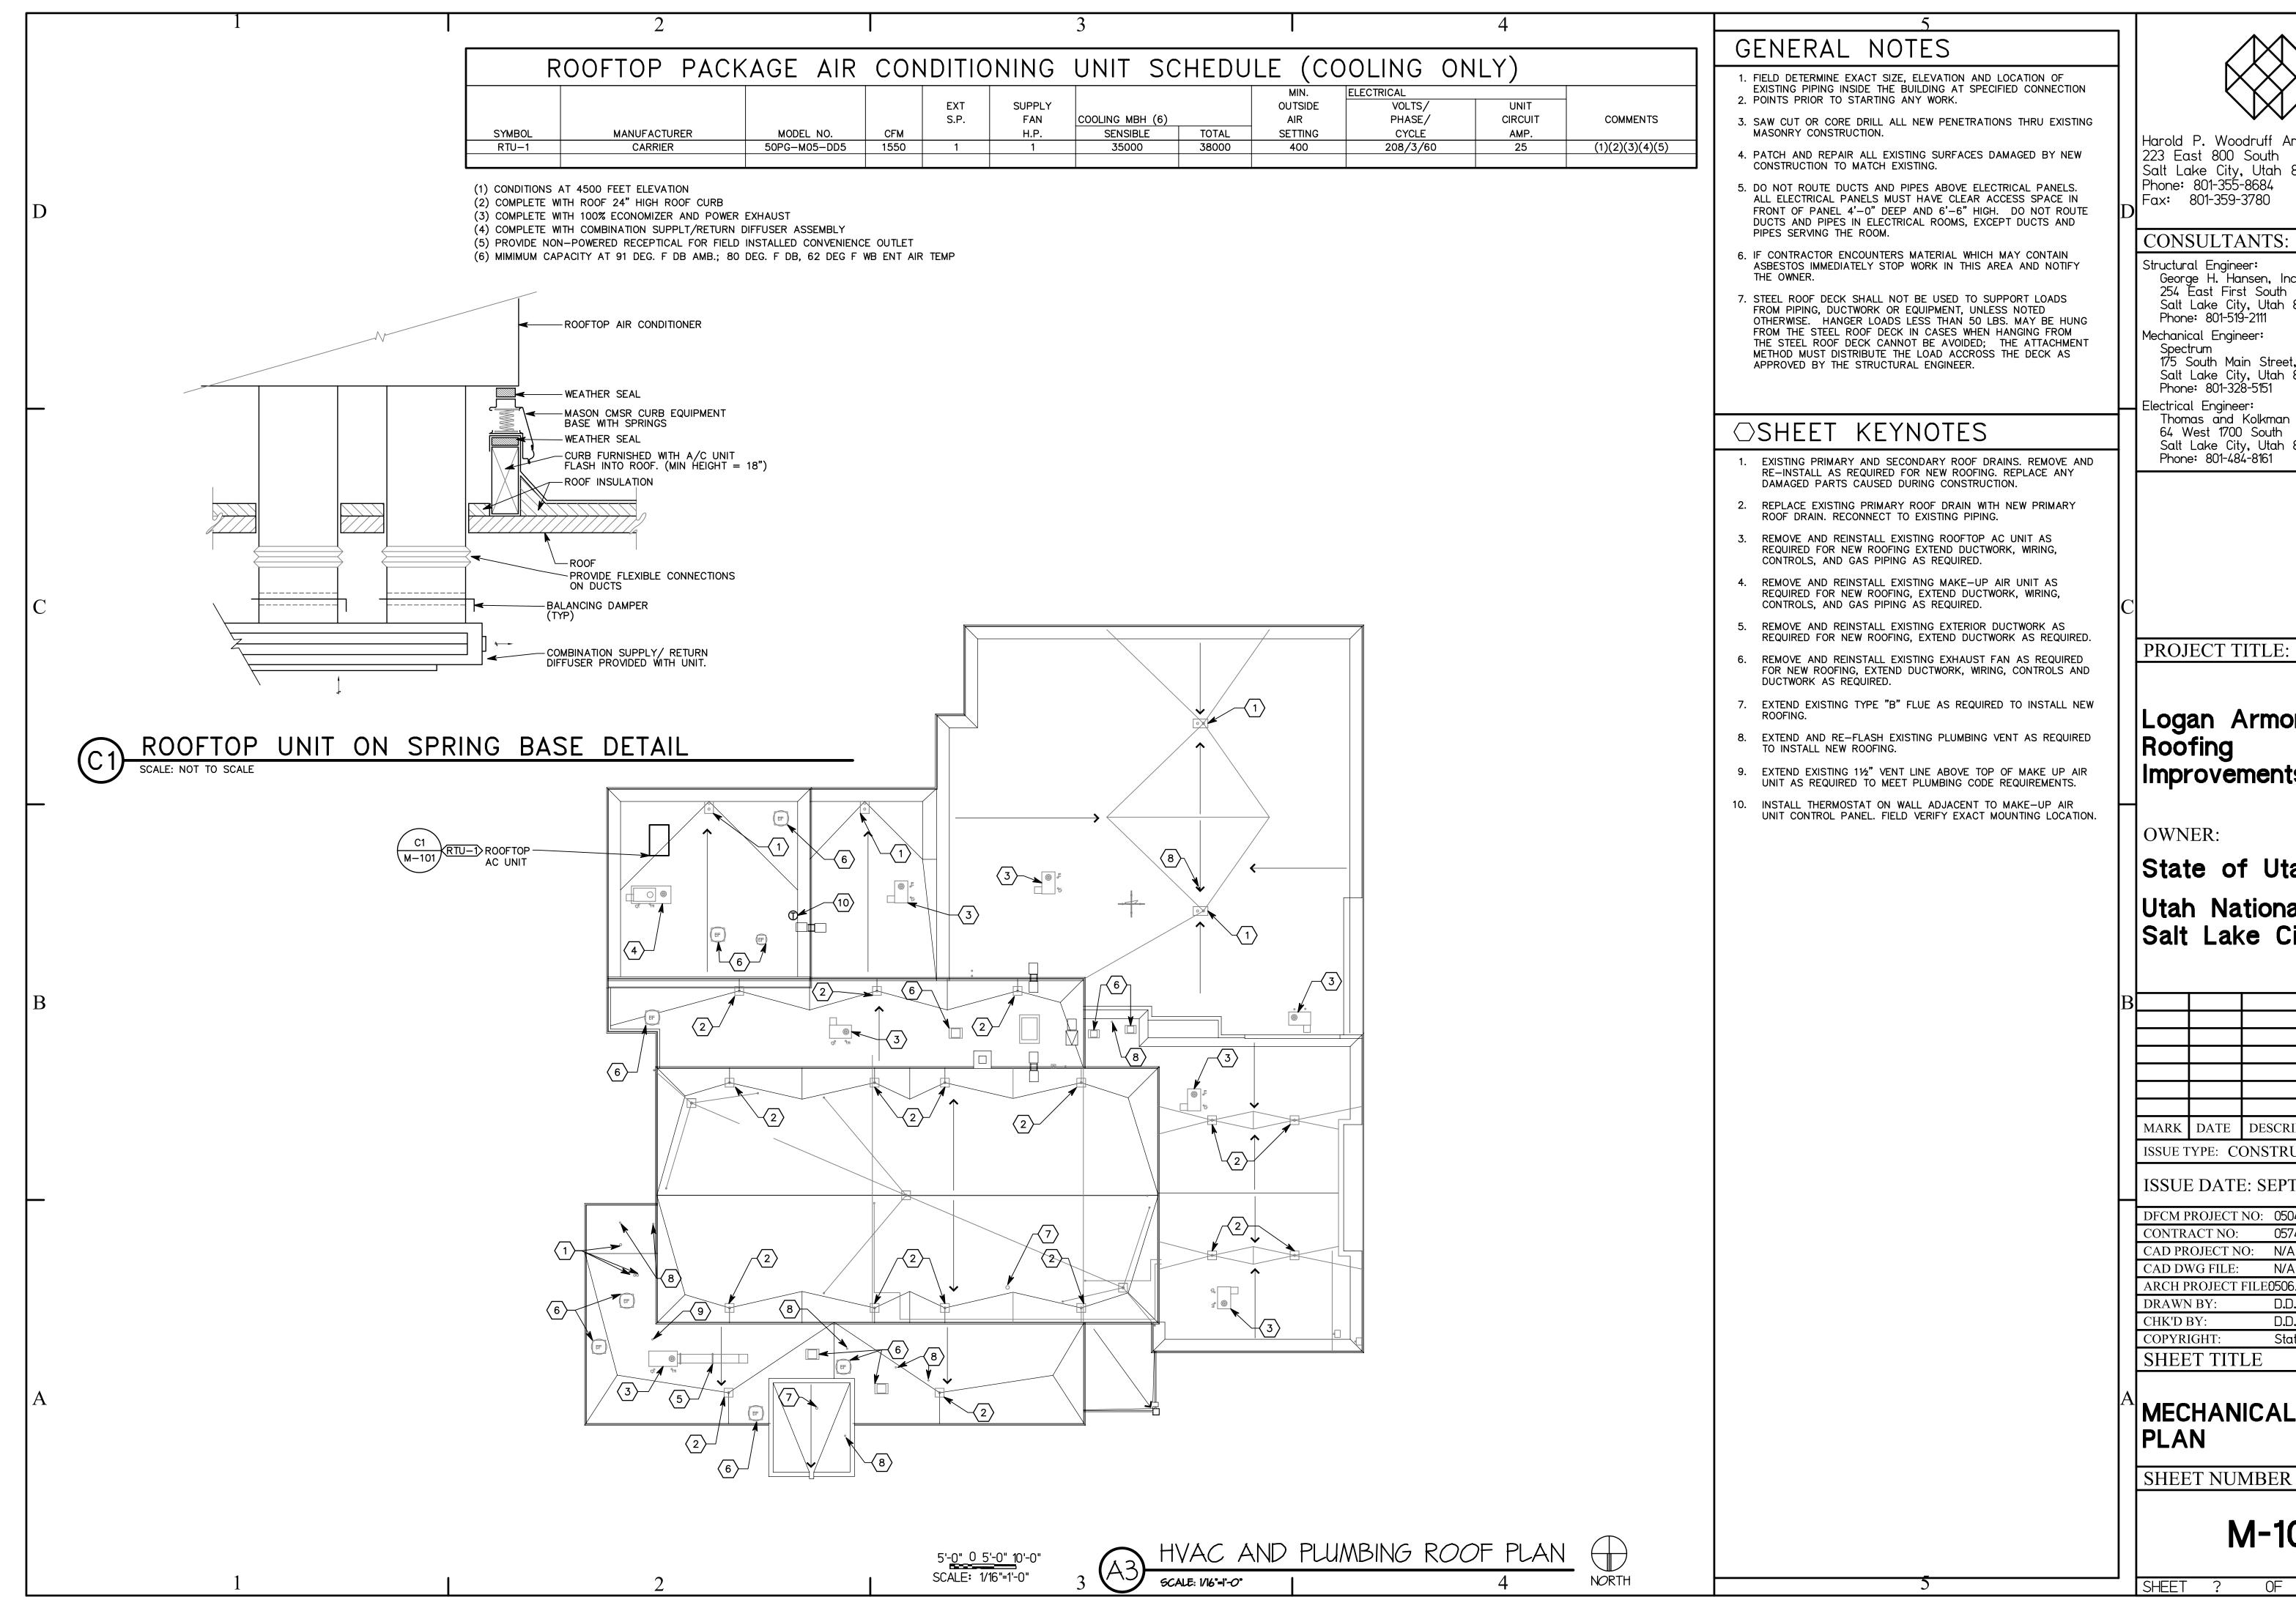

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175 South Main Street, Suite 300 Salt Lake City, Utah 84111

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Logan Armory-Roofing | Improvements

State of Utah-DFCM Utah National Guard Salt Lake City, Utah

MARK	DATE	DESCRIPTION
ISSUE T	ONSTRUCTION DOCS	


ISSUE DATE: SEPT. 19, 2005

DFCM PROJECT NO:	05041470
CONTRACT NO:	057471
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CAD DWG FILE:	N/A
ARCH PROJECT FILE	0506.pj\0506.db\aro.a
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SHEET TITLE	

MECHANICAL ROOF

M-101

OF

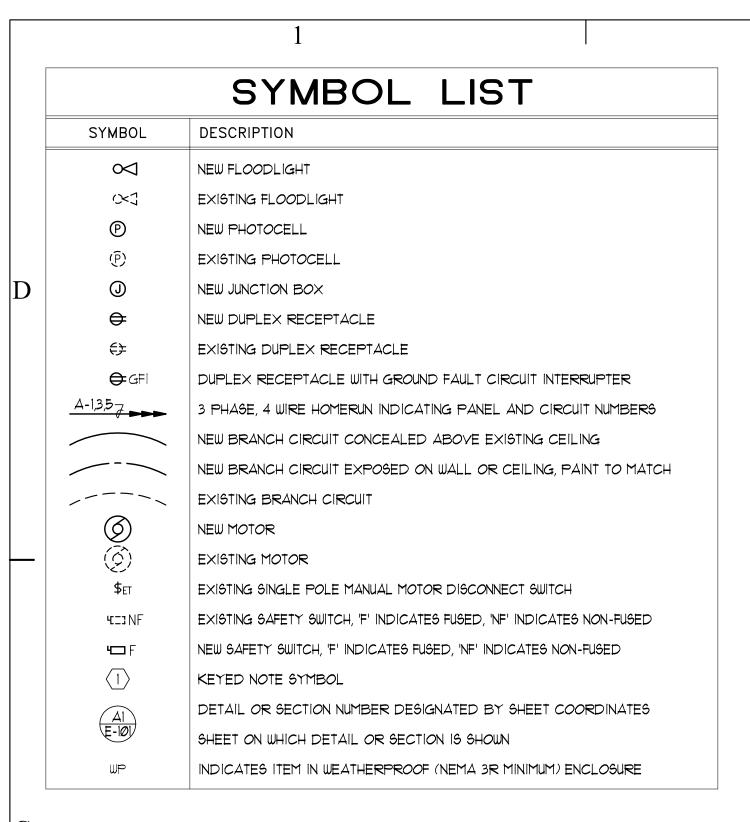

- ANTENNA CABLES TO BE PROVIDED

SEE ROOF ELECTRICAL PLAN

NEW 1 #8 GND, 3/4" C, FROM GROUNDING

BUSHINGS TO GROUND BUS IN EXISTING

MAIN BREAKER, IN ACCORDANCE WITH

-NEW CONDUIT SUPPORT IN ACCORDANCE

WITH SPEC. SECTION 16110. (TYPICAL)

—NEW SCREW COVER PULLBOX,

MINIMUM 12" $W \times 6$ " $H \times 4$ " D. PAINT TO MATCH BEAM.

FOR CONTINUATION OF CONDUITS.

BY UTAH NATIONAL GUARD.

*8 COPPER GROUND CONDUCTOR, BOND TO ANTENNA MAST, SATELLITE, AND/OR

SUPPORT STRUCTURES WITH PIPE CLAMP.

 \sim NEW PIPE FLASHING, SEE DETAIL $\frac{\text{B5}}{\text{A-501}}$

NEC 810-15 AND 810-21.

∠BOTTOM OF EXISTING GLU-LAM BEAM

SCALE: 3/4" = 1'-0"

ANTENNA MAST DETAIL

NEW WEATHERHEAD,

MINIMUM 36" ABOVE ROOF

NEW 2" GALVANIZED

NEW 1-1/4" C WITH PULL STRING,

FOR ANTENNA CABLES. -

NEW 2 HOLE CONDUIT

EXISTING GLU-LAM BEAM

MINIMUM 18" APART. —

STRAP SECURED TO

PAINT CONDUIT TO

MATCH BEAM (TYP.)-

WITH GROUNDING

BUSHING. (TYPICAL.

CONDUIT CONNECTORS

RIGID STEEL CONDUIT-

EQUIPMENT SCHEDULE											
QUIP. NO.	DESCRIPTION	CIRCUIT NUMBER	∨OLTS	PHASE	WATTS H.P.	BREAKER	S FURNISH	TARTER INSTALL		AUX. CONT.	LOCATION
RTU-1	ROOFTOP AC UNIT	P3-31	208	3	22.1 AMPS	3P-3ØA	Σ	M	М	-	ON ROOF
							E - E	ELECTRI	CAL CO	ONTRAC'	 T <i>o</i> r

FIXTURE SCHEDULE					
	SYMBOL	MANUFACTURER	CATALOG NUMBER	DESCRIPTION	LAMP
	F-1	GARDCO LSI INDUSTRIES	DF7-J-NSP-150MH-120-BRP/BD SLS-150MH-MT-SP25-BRZ-BD/SLS-WM- BRZ	WALL MOUNTED METAL HALIDE "ARCHITECTURAL" FLOODLIGHT WITH CAST ALUMINUM HOUSING, DARK BRONZE FINISH, NARROW SPOT LIGHT DISTRIBUTION, BARN DOOR VISOR, AND 120 VOLT HIGH POWER FACTOR BALLAST. SUITABLE FOR OUTDOOR WET	150 W MH ED-17

LOCATION, ABOVE HORIZONTAL AIMING.

M - MECHANICAL CONTRACTOR

$\langle 27 \rangle$ BUILDING WALLS BELOW 3P-29, IP-20A, 2 #12, ROOF SHOWN DASHED. 3P-31, 3P-30A 25 NOT ALL WALLS ARE 3 #10, 1 #10 GND, 3/4" C-SHOWN. (TYPICAL) (6) (RTU-I) WP F -----3P-21, 2P-50A (2) -3P-2, 2P-5 \emptyset A 2 *8, 1 *8 GND, 3/4 C | TWP / 2 #8, 1 #8 GND, 3/4" C 3P-22 -- / [|- Exist. #Anel 'P3|(5)(7) 3P-1, 3P-4ØA 3 #8, 1 #8 GND, 3/4" C 2 F\wp. 3P-15, 3P-40A 3 *8, 1 *8 GND, 3/4" C -3P-1, 2P-50A 2 #8, 1 #8 GND, 3/4" C APPROXIMATE LOCATION OF 5 EXIST. PANEL 'IK GLU-LAM BEAM BELOW ROOF ---(15)(16) 2 #8, 1 #8 GND, 3/4" C IK-7, 3P-30A, 3 #10, 1 #10 GND, 3/4" C IK-36, 3P-20A, 2 #12, 1 #12 GND, 3/4" C -

EXISTING 3P-1000A

MAIN BREAKER,

120/208 V, 3¢-

ROOF ELECTRICAL PLAN



KEYED NOTES:

GENERAL ELECTRICAL NOTES:

ARCHITECTURAL ROOF PLAN, SHEET A-101.

REPAIRS WITH THE GENERAL CONTRACTOR.

COMPLETION OF THE WORK.

1. COORDINATE EXISTING ROOFTOP EQUIPMENT LOCATIONS WITH

2. LOCATIONS OF EXISTING ELECTRICAL EQUIPMENT, BRANCH CIRCUIT WIRING,

ETC., ARE BASED ON EXISTING BUILDING ELECTRICAL DRAWINGS AND FIELD OBSERVATION OF EXISTING SURFACE CONDITIONS. FIELD VERIFY

EXISTING LOCATIONS AND CIRCUITING AND IMMEDIATELY NOTIFY THE

ARCHITECT OF ANY DISCREPANCIES WHICH MAY ADVERSELY AFFECT

VERIFY QUANTITIES AND LOCATIONS OF ALL EXISTING MATERIAL AND

EQUIPMENT TO BE REMOVED. REMOVE ALL ABANDONED CONDUIT WIRING,

4. TAKE ALL PRECAUTIONS NECESSARY TO AVOID DAMAGE TO THE EXISTING

BUILDING. REPAIR ALL DAMAGE INCURRED BY DEMOLITION AND NEW

CONSTRUCTION TO EXACTLY MATCH SURROUNDING SURFACES AND/OR

CONDITIONS WITHOUT ADDITIONAL COST TO THE OWNER. COORDINATE

5. REPLACE ALL EXISTING LIQUID-TIGHT FLEXIBLE CONDUIT AT EQUIPMENT

CONNECTIONS ON ROOF WITH NEW LIQUID-TIGHT FLEXIBLE STEEL CONDUIT.

JUNCTION BOXES, OUTLETS, EQUIPMENT, ETC. WHETHER SPECIFICALLY SHOWN

3. DEMOLITION IS SHOWN FOR CONTRACTORS REFERENCE ONLY. FIELD

- (I) DISCONNECT ELECTRICAL SERVICE TO EXISTING ROOFTOP EXHAUST FAN TO ALLOW EQUIPMENT REMOVAL AND INSTALLATION OF NEW ROOF. RECONNECT ELECTRICAL SERVICE UPON REINSTALLATION OF EQUIPMENT. EQUIPMENT WILL BE RAISED FOR INSTALLATION OF NEW ROOF. EXTEND EXISTING CONDUIT TO RAISED EQUIPMENT AND PROVIDE NEW CONDUCTORS OF SUFFICIENT LENGTH REQUIRED TO RECONNECT THE EQUIPMENT.
- (2) DISCONNECT ELECTRICAL SERVICE TO EXISTING PACKAGED ROOFTOP HEATING AND COOLING TO ALLOW EQUIPMENT REMOVAL AND INSTALLATION OF NEW ROOF. RECONNECT ELECTRICAL SERVICE UPON REINSTALLATION OF EQUIPMENT. EQUIPMENT WILL BE RAISED FOR INSTALLATION OF NEW ROOF. EXTEND EXISTING CONDUIT TO RAISED EQUIPMENT AND PROVIDE NEW CONDUCTORS OF SUFFICIENT LENGTH REQUIRED TO RECONNECT THE EQUIPMENT.
- \langle 3 \rangle DISCONNECT ELECTRICAL SERVICE TO EXISTING ROOFTOP MAKE-UP AIR UNIT TO ALLOW EQUIPMENT REMOVAL AND INSTALLATION OF NEW ROOF. RECONNECT ELECTRICAL SERVICE UPON REINSTALLATION OF EQUIPMENT. EQUIPMENT WILL BE RAISED FOR INSTALLATION OF NEW ROOF. EXTEND EXISTING CONDUIT TO RAISED EQUIPMENT AND PROVIDE NEW CONDUCTORS OF SUFFICIENT LENGTH REQUIRED TO RECONNECT THE EQUIPMENT.
- $\overline{\langle 4 \rangle}$ disconnect and reconnect existing control conduits and wiring to EXISTING ROOFTOP MAKE-UP AIR UNIT AS REQUIRED FOR ELECTRICAL SERVICE TO THE MAKE-UP AIR UNIT.
- (5) APPROXIMATE LOCATION OF EXISTING 120/208 VOLT, 3 PHASE PANELBOARD, ON MAIN FLOOR BELOW ROOF.
- (6) NEW PACKAGED ROOFTOP AIR CONDITIONING UNIT. PROVIDE NEW FUSED SAFETY SWITCH AND ELECTRICAL SERVICE AS SHOWN. PROVIDE FUSE SIZE IN ACCORDANCE WITH ROOFTOP UNIT NAMEPLATE. FIELD COORDINATE ROUTING OF NEW CONDUIT THROUGH BUILDING WITH EXISTING CONDITIONS.
- \langle 1 \rangle PROVIDE NEW GENERAL ELECTRIC TYPE 'THHQB', 3P-3ØA, 22 KAIC, BRANCH CIRCUIT BREAKER IN EXISTING PANEL 'P3' TO SERVE NEW ROOFTOP UNIT. REMOVE (3) IP-20A SPARE BREAKERS TO INSTALL NEW BREAKER AND SALVAGE BREAKERS FOR OWNER. PROVIDE NEW TYPEWRITTEN CIRCUIT INDEX TO REFLECT CIRCUIT CHANGES AND ADDITIONS.
- (8) PROVIDE NEW RECEPTACLE AT NEW ROOFTOP UNIT AND CONNECT TO SPARE IP-20A BREAKER IN EXISTING PANEL 'P3' AS INDICATED.
- (9) REMOVE EXISTING RECEPTACLE MOUNTED IN ROOF CURB INCLUDING OUTLET BOX AND CONDUIT TO BELOW ROOF. PROVIDE NEW RECEPTACLE MOUNTED ON EXISTING ROOFTOP UNIT, MINIMUM 24" ABOVE ROOF, AND CONNECT TO EXISTING RECEPTACLE CIRCUIT.
- (10) REPLACE EXISTING RECEPTACLE WITH NEW GFCI RECEPTACLE AND "RAINTIGHT WHILE IN USE" COVERPLATE IN EXISTING OUTLET BOX. RECONNECT EXISTING
- (11) REMOVE ABANDONED 3" ELECTRICAL SERVICE CONDUIT COMPLETE TO ABANDONED CT CABINET IN MECHANICAL ROOM BELOW. REPAIR ROOF AS REQUIRED FOR NEW ROOFING. REPAIR MECHANICAL ROOM CEILING AS REQUIRED TO MATCH SURROUNDING SURFACES.
- (12) REMOVE ABANDONED 1-1/2" TELEPHONE SERVICE CONDUIT COMPLETE. CONDUIT IS CUT OFF IN CEILING SPACE BELOW ROOF. REPAIR ROOF AS REQUIRED FOR NEW ROOFING.
- (13) EXISTING WEATHERHEAD MAST FOR EXISTING SATELLITE DISH TO REMAIN.
- (14) PROVIDE NEW WEATHERHEAD MAST AS SHOWN ON DETAIL AI/E-10/1 FOR EXISTING ANTENNA. EXISTING ANTENNA CABLES ARE TO BE REMOVED AND REINSTALLED BY UTAH NATIONAL GUARD. CONTRACTOR TO REPAIR EXISTING WINDOW FRAME AND INTERIOR WALLS AS REQUIRED TO MATCH SURROUNDING SURFACES WHERE CABLES ARE REMOVED.
- (15) NEW 1-1/4" CONDUIT WITH PULL STRING FOR NEW ANTENNA CABLES FROM NEW ANTENNA MAST TO EXISTING OFFICE.
- (16) INSTALL NEW CONDUIT EXPOSED ON SIDE OF EXPOSED BEAM, PAINT TO MATCH
- (17) TURN CONDUIT DOWN TO BOTTOM OF GLU-LAM BEAM.
- (18) INSTALL CONDUIT HORIZONTALLY NEAR BOTTOM OF EXPOSED GLU-LAM, PAINT TO MATCH WALL.
- (19) TURN CONDUIT DOWN TO APPROXIMATELY 10 FT ABOVE FLOOR. PROVIDE CONDUIT BODY AND EXTEND CONDUIT THROUGH EXISTING WALL INTO ACCESSIBLE CEILING SPACE OF EXISTING OFFICE. PAINT CONDUIT TO MATCH WALL.
- (20) TERMINATE ANTENNA CONDUIT WITH INSULATED BUSHING IN ACCESSIBLE CEILING SPACE OF EXISTING OFFICE. VERIFY EXACT LOCATION WITH UTAH NATIONAL
- (21) NEW #8 GROUND, 3/4" CONDUIT FROM NEW ANTENNA MAST TO EXISTING MAIN
- (22) TURN CONDUIT DOWN TO BELOW MECHANICAL ROOM CEILING, APPROXIMATELY 12 FT ABOVE FLOOR. PROVIDE CONDUIT BODY AND EXTEND CONDUIT THROUGH EXISTING WALL INTO MECHANICAL ROOM. PAINT CONDUIT TO MATCH WALL
- (23) INSTALL CONDUIT EXPOSED ON MECHANICAL ROOM CEILING.
- (24) INSTALL NEW CONDUIT CONCEALED ABOVE EXISTING GYPSUM BOARD CEILING.
- (25) INSTALL NEW CONDUIT CONCEALED ABOVE EXISTING ACOUSTICAL GRID CEILING.
- (26) INSTALL CONDUIT THROUGH EXPOSED STRUCTURE, PAINT TO MATCH PAINTED STRUCTURE.
- (27) DRILL AND FIRE SEAL EXISTING MASONRY WALL FOR NEW CONDUIT PENETRATION. SEE DETAIL DI/A-101.
- (28) EXISTING PHOTOCELL MOUNTED ON PARAPET WALL ABOVE ROOF TO REMAIN. RELOCATE EXISITNG 3/4" CONDUIT THROUGH ROOF TO BE CLEAR OF WALL FLASHING AND RECONNECT EXISTING CIRCUIT. NOTE GYPSUM BOARD CEILING IN CORRIDOR BELOW ROOF. COORDINATE REQUIREMENTS WITH ROOFING CONTRACTOR AND ARCHITECT.
- (29) REMOVE EXISTING FLAGPOLE FLOODLIGHT, PHOTOCELL, AND CONDUIT THROUGH ROOF. INTERCEPT EXISTING CIRCUIT IN NEW JUNCTION BOX IN ACCESSIBLE CEILING SPACE BELOW ROOF AND EXTEND CIRCUIT TO NEW PHOTOCELL, NEW FIXTURE, AND EXISTING LIGHTED SIGN.
- (30) PROVIDE NEW INTERMATIC *K4121, OR EQUAL PHOTOCELL RATED 1800 WATTS, 120 VOLT, TO CONTROL NEW F-1 FIXTURE AND EXISTING LIGHTED SIGN. INSTALL 12"± BELOW ROOF, FACING NORTH.
- $\langle 31 \rangle$ Provide New F-1 Fixture 12"± BELOW TOP OF EXTERIOR WALL AND AIM TO ILLUMINATE EXISTING FLAGPOLE. RECONNECT TO EXISTING CIRCUIT THROUGH NEW PHOTOCELL.
- $\langle 32
 angle$ Existing Exterior lighted sign to REMAIN. RECONNECT to Existing circuit HROUGH NEW PHOTOCELL.

Harold P. Woodruff Architect/Planner 233 East 800 South Salt Lake City, Utah 84111 Phone: 801-355-8684 Fax: 801-359-3780

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CHK'D BY:	R.G.K.
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SHEET TITLE

A ROOF ELECTRICAL PLAN AND DETAILS

SHEET NUMBER

E-101

SHEET OF